F.S. NOTES

SPRINKLER SYSTEM

SINCE THE TOTAL AREAS OF THIS LICENSE APPLICATION IS NOT EXCEEDING 230 SQUARE METER. SPRINKLER SYSTEM SHALL NOT BE PROVIDED.

MANUAL FIRE ALARM SYSTEM

- A MANUALLY OPERATED FIRE ALARM SYSTEM SHALL BE PROVIDED FOR LICENSE AREA OF ENTRANCE.
- VISUAL FIRE ALARM TO BE PROVIDED AND BE LOCATED AT A PROMINENT LOCATION IN PLACES WHICH ARE INTENDED TO BE ACCESSIBLE TO THE PUBLIC.

HOSE REEL SYSTEM

- HOSE REEL SYSTEM SHALL BE PROVIDED FOR WHOLE BUILDING.
- THERE ARE SUFFICIENT HOSE REEL TO ENSURE THAT EVERY PART OF THE BUILDING CAN BE REACHED BY A LENGTH OF NOT MORE THAN 30M OF HOSE REEL TUBING.
- HOSE REEL PUMPS (ON DUTY AND STANDBY) SHALL BE PROVIDED FOR HOSE REEL SYSTEM.
- A 2000 LITERS HOSE REEL WATER TANK SHALL BE PROVIDED TO SERVE HOSE REEL SYSTEM.

EXIT SIGN

SUFFICIENT EXIT SIGN AND DIRECTIONAL SIGN SHALL BE PROVIDED WITHIN THE LICENSE AREA TO ENSURE THAT ALL EXIT ROUTES AREA CLEARLY INDICATED AND COMPLY WITH FSD CIRCULAR LETTER 5/2008 AND FIRE CODE OF PRACTICE.

EMERGENCY LIGHTING

EMERGENCY LIGHTING SHALL BE PROVIDED FOR THE LICENSE AREA IN ACCORDANCE WITH BS5266 PART 1 AND PPA/104A.

POTABLE EQUIPMENT

PORTABLE FIRE EXTINGUISHERS SHALL BE PROVIDED AT E POSITION AS SHOWN ON PLANS.


FIRE DETECTION SYSTEM

- SMOKE DETECTOR WITH SOUNDER BASE SHALL BE PROVIDED IN SLEEPING ACCOMMODATION OF LICENSE AREA.
- 12. THE DETECTOR SHALL BE OF FSD APPROVED TYPE.
- ON MAIN FIRE ALARM CONTROL PANEL SHALL BE PROVIDED AS INDICATED ON PLANS TO RECEIVE ALL FIRE ALARM SIGNALS.
- HEAT DETECTOR SHALL BE PROVIDED FOR LAVATORY AND SMOKE DETECTOR SHALL BE PROVIDED FOR LIVING ROOM AND CORRIDOR.
- ALL FIRE ALARM SIGNALS INCLUDED FIRE DETECTORS, MANUAL FIRE ALARM CALL POINT SHALL BE LINKED TO FSD COMMUNICATION CENTRE VIA. DIRECT LINE PROVIDED BY THE AUTHORIZED SERVICE SERVICE PROVIDER OF THE COMPUTERIZED FIRE ALARM TRANSMISSION SYSTEM.

LEGEND

		LICENSE AREA	的/匝	FIRE HOSE REEL	OFE1	SKG DRY POWDER FIRE EXTINGUISHER
(§	(6	SMOKE DETECTOR	×	GATE VALVE	O _{FE2}	9L WATER TYPE FIRE EXTINGUISHER
- 1	SB	SMOKE DETECTOR WITH SOUNDER BASE	N	CHECK VALVE	PEJ	5KG CO2 GAS TYPE FIRE EXTINGUISHER
Œ	4	HEAT DETECTOR	M	FLEXIBLE CONNECTOR	EXIT	EXIT SIGN BOX
Ç	(REMOTE INDICATION LAMP	7	Y-TYPE STRAINER		DIRECTIONAL SIGN BOX
C	(W	REMOTE INDICATION LAMP (WEATHERPROOF TYPE)	0	BALL FLOAT VALVE	Q	FIRE ALARM BELL
		VISUAL FIRE ALARM		STRAINER	AFA全	MASTER FIRE ALARM BELL
C		EMERGENCY LIGHTING WITH BACK UP BATTERY	+	CHECK METER POSITION		MONITOR MODULE

PROJECT:

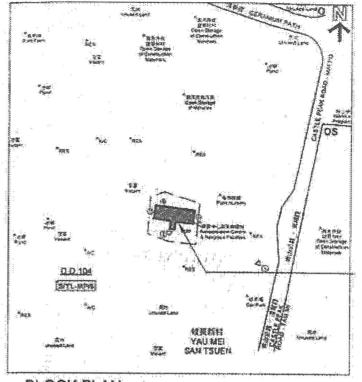

元朗米埔丈量約份 第104約地段 第4620號1樓 FIRST FLOOR, LOT 4620 IN D.D. 104, MAI PO, YUEN LONG

BLOCK PLAN

AAVA

ABBREVIATION

L/L H/L FSD WSD COP T/A	LOW LEVEL HIGH LEVEL FIRE SERVICES DEPARTMENT WATER SUPPLIES DEPARTMENT CODE OF PRACTICE TO ABOVE	F.S S.S. H.R.	FIRE EXTINGUISHER FIRE SERVICES STAINLESS STEEL HOSE REEL AITOMATIC AIR VENT
T/B	TO BELOW		
F/A	FROM ABOVE		
Ø	PRESCRIPT ALLOS DALL		CODE CIZEC:
BX	PRESSURE GAUGE C/W BALL VALVE	FUR PIPE	SIZES:
Ø	PRESSURE SWITCH	PIPE SIZE	COLOUR CODE
1.11.757	LOTABLETA LISTE	25mm diamete	r GREEN ———

AUTOMATIC AIR VENT 40mm diameter LEVEL FLOAT SWITCH 50mm diameter

YELLOW

PURPLE

0 MANUAL FIRE ALARM CALL POINT

FS F.S. CONTROL PANEL

0 HOSE REEL PUMP

C CONTROL MODULE

FSI CONTRACTOR:

RE PROTECTION WING KAI ENG. CO. No. 8, 7/F., Kingsford Industrial Centre, 13 Wang Hoi Road, Kowloon Bay, Kln Tel:27561722 Fax:27951775


CLIENT:


MISSION ARK LTD.

元朗米埔丈量約份 第104約地段 第4620號1樓 (闢臨時社會福利設施藥物倚賴者治療及康復中心) F.S. NOTES, LEGEND, BLOCK PLAN. ABBREVIATION AND COLOUR CODE FOR PIPE SIZES


				SCALE: DRAWN:	NTS CAD	JOB NO.: WK230927
R1	REVISED	09/2023		CHECKED:	ск но	DRAWING NO.:
NO.	REVISIONS	DATE:	BY	DATE:		FS-01



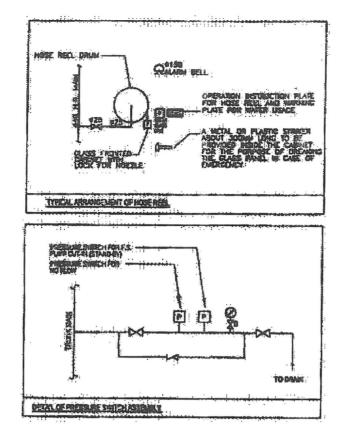

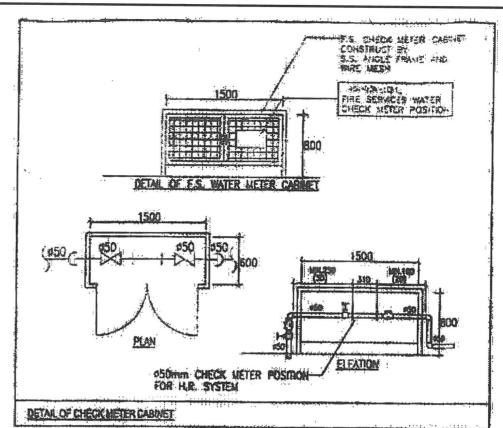

FS PUMP SCHEDULE

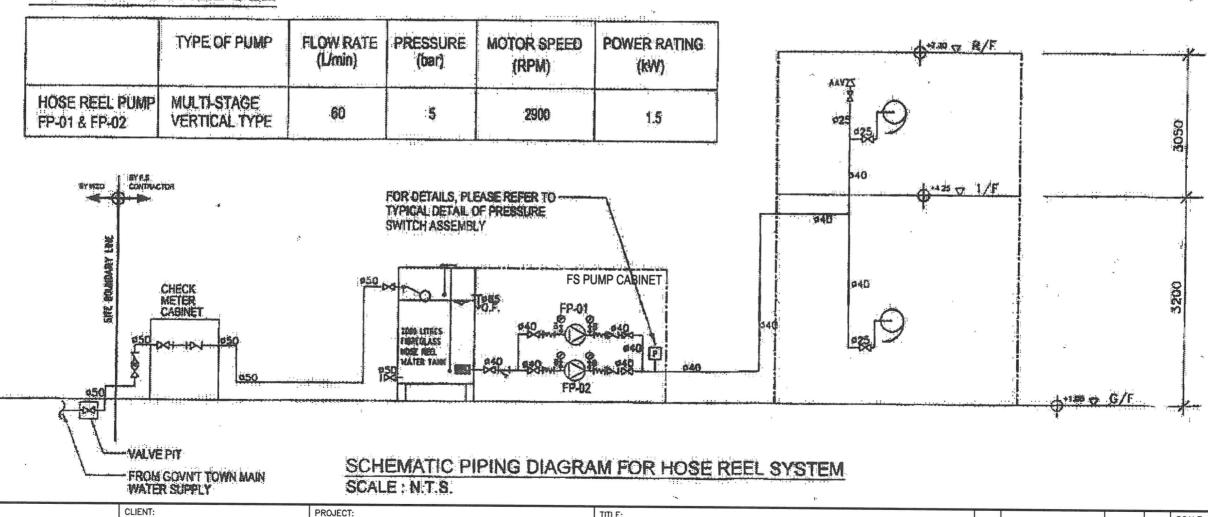

TITLE:


FSI CONTRACTOR:

WING KAI ENG. CO. No. 8, 7/F., Kingsford Industrial Centre, 13 Wang Hoi Road, Kowloon Bay, Kin Tel:27561722 Fax:27951775 MISSION ARK LTD.

元朗米埔丈量約份 第104約地段 第4620號1樓 (闢臨時社會福利設施藥物倚賴者治療及康復中心)

SCHEMATIC PIPING DIAGRAM FOR HOSE REEL SYSTEM AND PUMP SCHEDULE

=		and the second s	The state of the s	1000		
					SCALE:	JOB NO.:
					DRAWN:	WK230927
	R1	REVISED	09/2023		CHECKED: CK HO	DRAWING NO.:
	NO.	REVISIONS	DATE:	BY	DATE:	FS-02

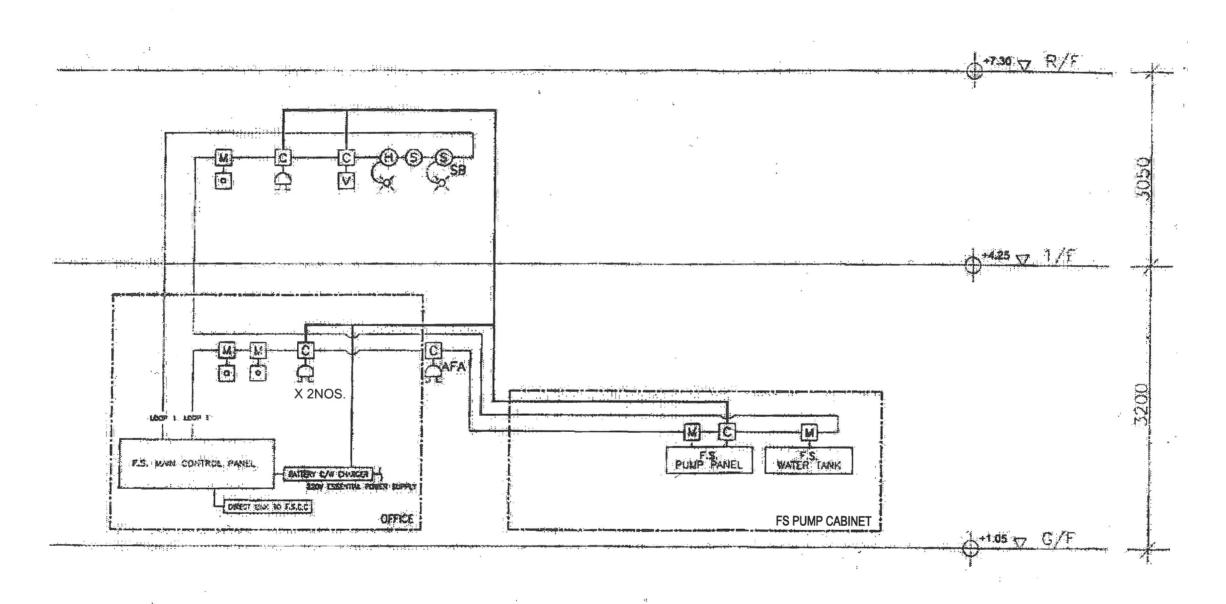

SCHEMATIC CONTROL WIRING DIAGRAM FOR FIRE ALARM SYSTEM SCALE: N.T.S.

FSI CONTRACTOR:

FIRE PROTECTION

WING KAI ENG. CO.
No. 8, 7/F., Kingsford Industrial Centre,
13 Wang Hoi Road, Kowloon Bay, KIn
Tel:27561722 Fax:27951775

CLIENT:


MISSION ARK LTD.


元朗米埔丈量約份 第104約地段 第4620號1樓 (關臨時社會福利設施藥物倚賴者治療及康復中心)

PROJECT:

SCHEMATIC CONTROL WIRING DIAGRAM FOR FIRE ALARM SYSTEM

			Name and Address of the Owner, where	The same of the sa		
				SCALE:	NTS	JOB NO.:
				DRAWN:	CAD	WK230927
R1	REVISED	09/2023		CHECKED:	ск но	DRAWING NO.:
NO.	REVISIONS	DATE:	BY	DATE:		FS-03

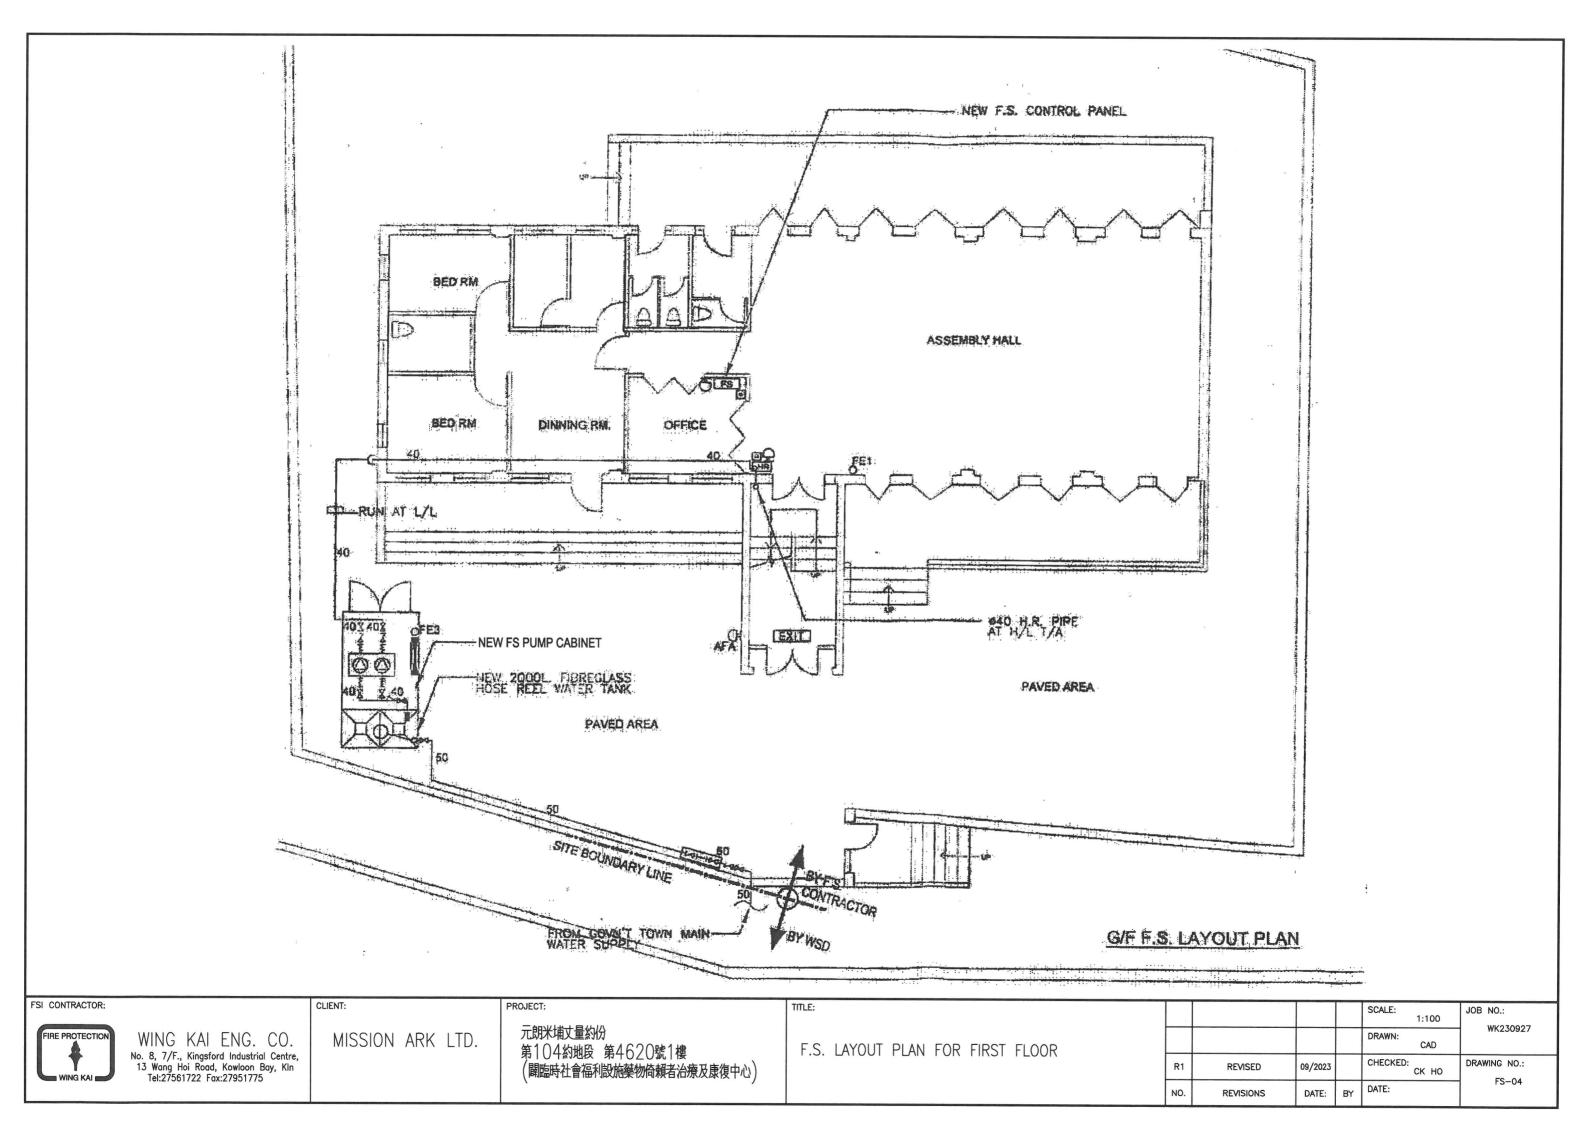

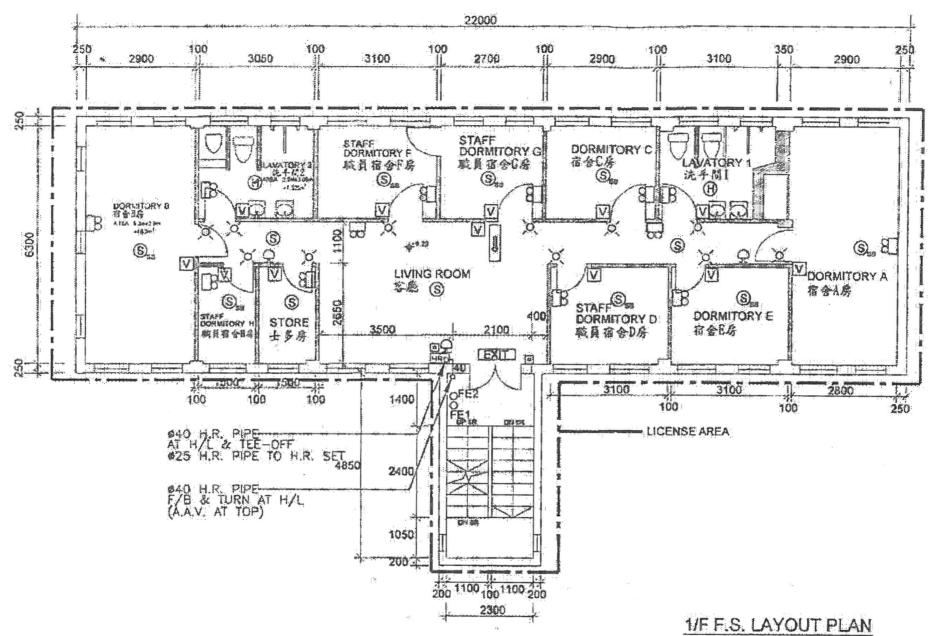

TOTAL FLOOR AREA: (22m x 6.3m) + (4.85m x 2.3m)

= 138.6m² + 11.155m² = 149.755m²

CONCLUSION, TOTAL LICENSE FLOOR AREA IS 149.755m, WHICH IS LESS THAN 230m², THEREFOR NO SPRINKLER SYSTEM IS REQUIRED.

FSI CONTRACTOR:

FIRE PROTECTION
WING KAI

WING KAI ENG. CO.
No. 8, 7/F., Kingsford Industrial Centre,
13 Wang Hoi Road, Kowloon Bay, Kin
Tel:27561722 Fax:27951775

CLIENT:

MISSION ARK LTD.

PROJECT:

元朗米埔丈量約份 第104約地段 第4620號1樓 (關臨時社會福利設施藥物倚賴者治療及康復中心) TITLE:

F.S. LAYOUT PLAN FOR FIRST FLOOR

				SCALE: 1:100	JOB NO.:
				1.100	WK23092
				DRAWN:	111125052
				CAD	
R1	REVISED	09/2023		CHECKED:	DRAWING NO.:
		,		ск но	50.05
NO.	REVISIONS	DATE:	BY	DATE:	FS-05